


- KEYED NOTES (#)**
1. SEALED EDGE ISOLATION JOINT (SEI)
 2. CONTROL JOINT (CJ)
 3. CONSTRUCTION JOINT (CSJ)
 4. 6" CONCRETE CORE ICF WALL (TYP.)


FOR SLAB-ON-GRADE AND JOINT DETAILS, SEE DRAWING S1.
 FOR ACTUAL TOP OF SLAB ELEV., SEE CIVIL DWGS.
 SUGGESTED SLAB-ON-GRADE JOINT ARRANGEMENT IS SHOWN, ALTERNATIVE JOINT ARRANGEMENT MEETING ACI CODE REQUIREMENTS MAY BE SUBMITTED BY CONTRACTOR FOR APPROVAL.

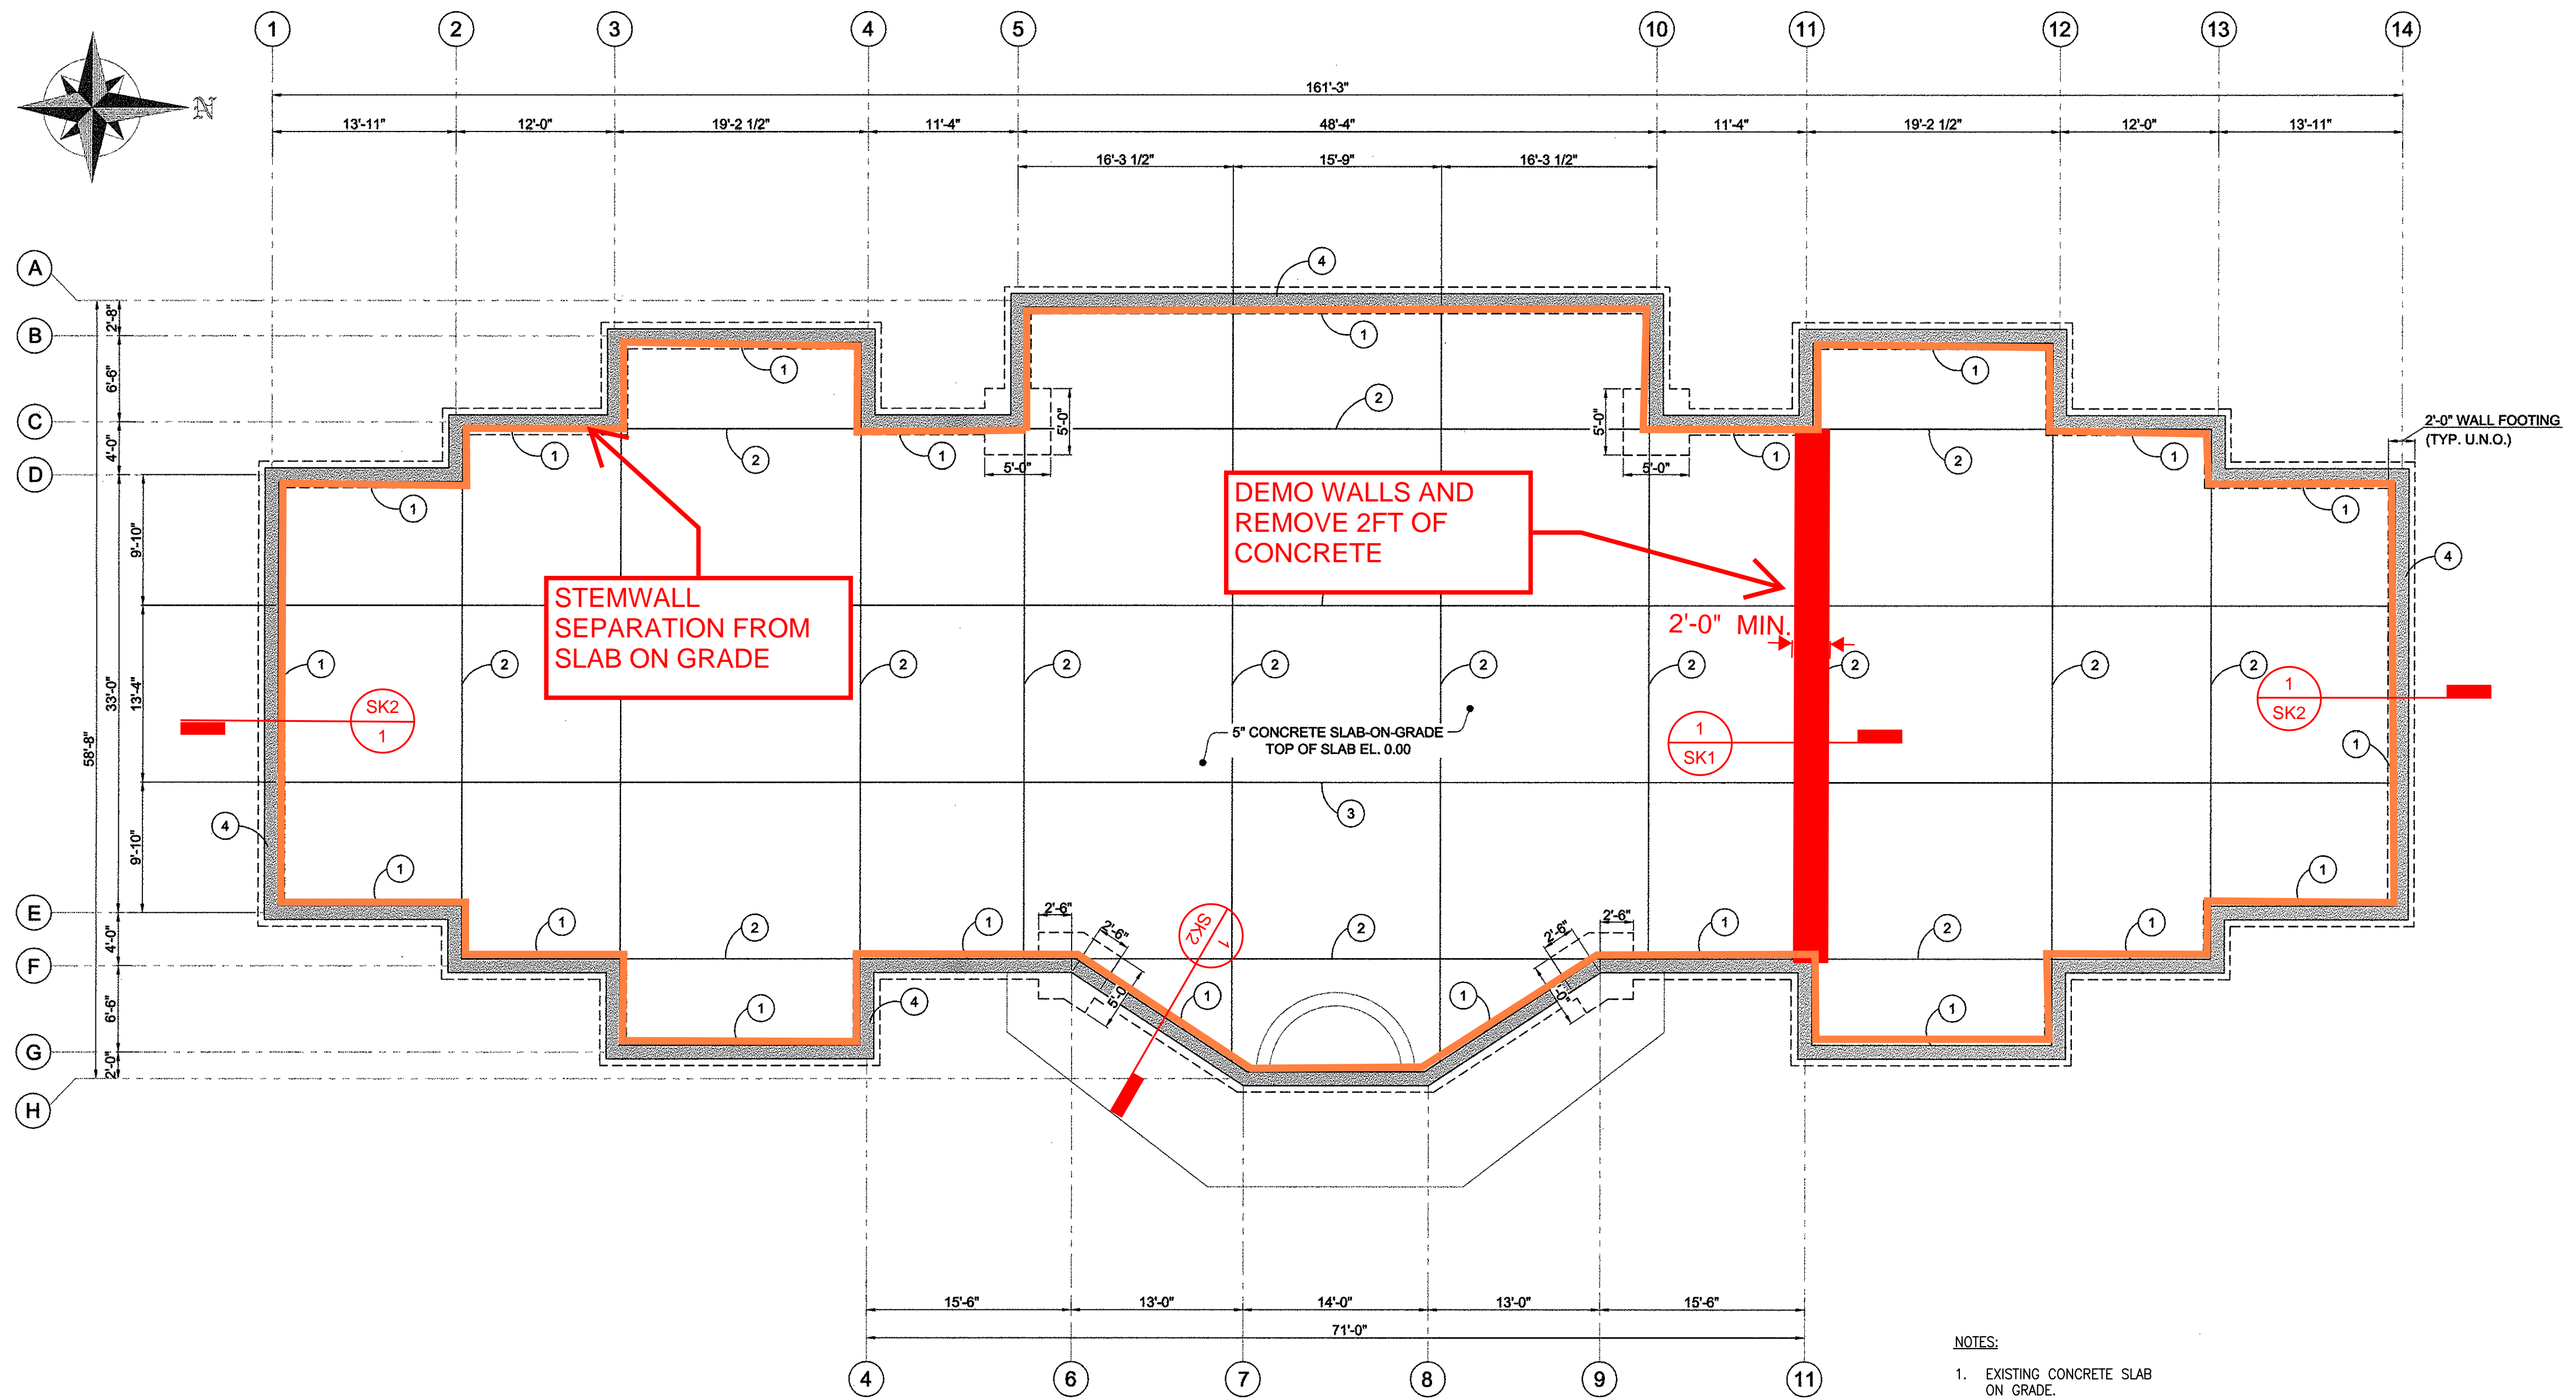


FOUNDATION PLAN
 SCALE 3/8" = 1'-0"

- NOTES:**
1. EXISTING CONCRETE SLAB ON GRADE.
 2. NEW CONCRETE SLAB ON GRADE.
 3. #3 x 1'-6" LONG AT 24" O.C. DRILL AND EPOXY INTO EXISTING CONCRETE SLAB (5" EMBED), STAGGERED.
 4. (2) #4 CONTINUOUS.
 5. #4 BARS AT 12" O.C.

- NOTES:**
1. ICF WALL.
 2. TOP OF ADJACENT CONCRETE STEM WALL.
 3. EXISTING CONCRETE SOG OR GRADE.
 4. CONCRETE FOOTING.
 5. 12" CONCRETE STEM WALL.
 6. 5/8" DIA. x 1'-6" LONG AT 5'-0" O.C. DRILL AND EPOXY INTO EXISTING CONCRETE SLAB (5" EMBED).
 7. NUT AND 3" SQUARE STEEL WASHER.

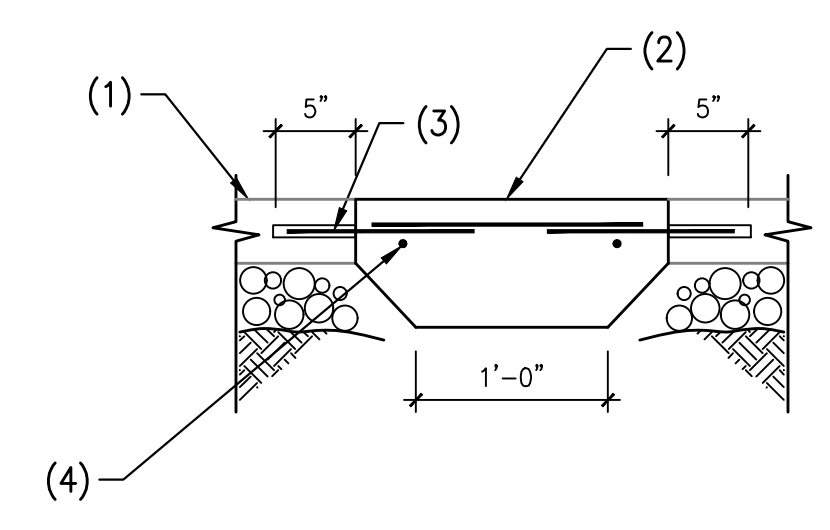

SK1 NEW CONCRETE SLAB AT EXISTING CONCRETE SLAB
 SCALE: NOT TO SCALE

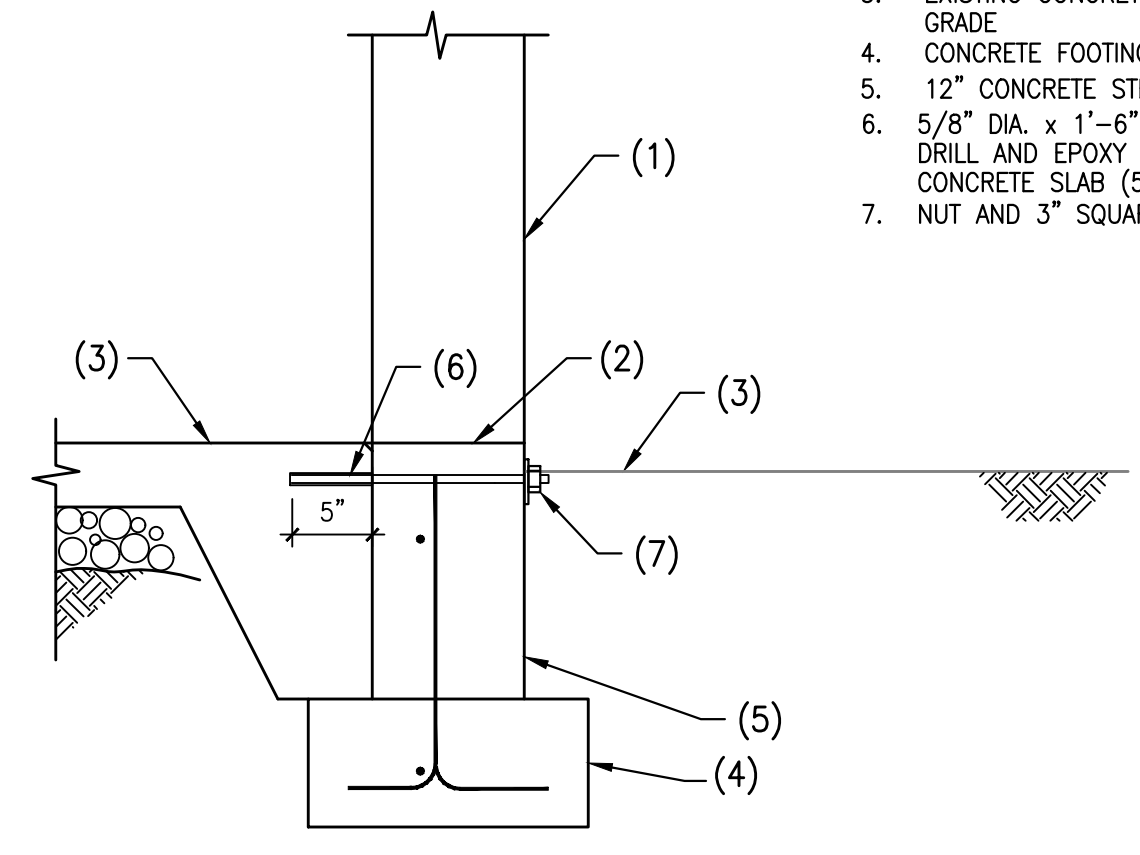

SK2 CONCRETE STEM WALL TO SOG CONNECTION
 SCALE: NOT TO SCALE

Project: SAGE MEMORIAL - GROUP HOME PROJECT GANADO, AZ

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NO.	DATE	REVISION	BY

foundation plan

ENGINEER	CHECKED BY
JOB NO	DRAWN BY
SCALE	DATE
DWG NO	
S200	
SHEET NO	